FOSTER-TANNER ELECTRICAL GEAR REPLACEMENT


FOR FLORIDA A&M UNIVERSITY TALLAHASSEE, FL

MARCH 29, 2024 FOR CONSTRUCTION



PROJECT LOCATION

FOSTER-TANNER MUSIC CENTER TALLAHASSEE, FL 32310

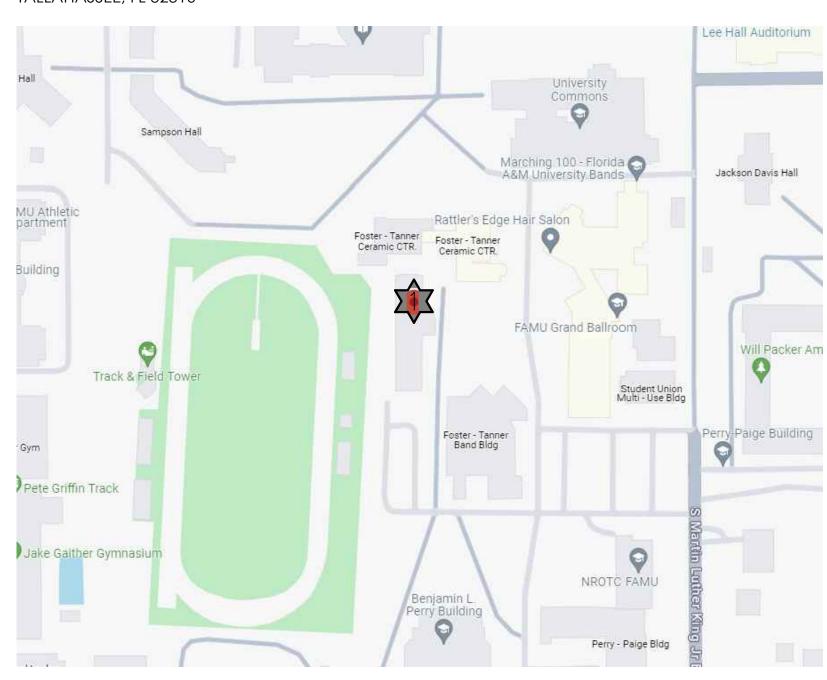

CODES AND STANDARDS

FLORIDA BUILDING CODE SEVENTH EDITION, 2020 FLORIDA FIRE PREVENTION CODE SEVENTH EDITION, 2020 STATE REQUIREMENTS FOR EDUCATIONAL FACILITIES, 2014 NATIONAL ELECTRIC CODE, NFPA 70, 2017

INDEX OF DRAWINGS

ELECTRICAL:

1 LEGEND & NOTES

E-002 SITE PLAN

E-101 ELECTRICAL GROUND FLOOR POWER PLAN

DESIGN TEAM

ELECTRICAL/PRIME:



4452 Clinton Street, Marianna, Florida 32446 850.526.3447 Project Number: 2023-085 Florida Certificate of Authorization: 27825 Anthony L Davis, PE Florida License 57419

STATEMENT OF COMPLIANCE

TO THE BEST OF MY KNOWLEDGE, THESE DRAWINGS AND THE PROJECT MANUAL ARE COMPLETE AND COMPLY WITH THE FLORIDA BUILDING CODE

ENGINEER OF RECORD: ANTHONY L. DAVIS, PE FL LICENSE 57419

ELECTRICAL GENERAL NOTES

- 1. CONTRACTOR SHALL COORDINATE ALL WORK WITH OTHER TRADES PRIOR TO INSTALLATION. REFER TO A/V DRAWINGS FOR REQUIRED RACEWAYS, EXACT SIZE, AND LOCATION OF EQUIPMENT WHICH IS FURNISHED BY OTHERS AND CONNECTED BY ELECTRICAL.
- 2. RECEPTACLES, SWITCHES AND COVERPLATES COLOR SHALL BE SELECTED BY THE ARCHITECT FROM STANDARD COLORS.
- 3. LOCATION OF LIGHTING FIXTURES, DISCONNECT SWITCHES, ETC. FOR AUDIO-VISUAL EQUIPMENT/ROOM SHALL BE COORDINATED WITH FINAL 'AV' EQUIPMENT LOCATIONS TO PROVIDE NATIONAL ELECTRIC CODE REQUIRED ACCESS SPACE.
- 4. FINAL CONNECTION TO ALL MOTORS SHALL BE WITH FLEXIBLE CONDUIT CONNECTION.
- 5. ALL EXIT AND EMERGENCY FIXTURES SHALL BE CONNECTED TO LIGHT CIRCUIT AHEAD OF LOCAL SWITCH.
- 6. ALL PANELBOARDS, BACKBOARDS, TERMINAL CABINETS, ETC SHALL HAVE CUSTOM ENGRAVED MICARTA NAMEPLATE MECHANICALLY AFFIXED IDENTIFYING SYSTEM. 7. GENERAL CONTRACTOR SHALL FIELD-VERIFY ALL EXISTING CONDITIONS PRIOR TO BEGINNING ANY WORK, AND SHALL IMMEDIATELY NOTIFY THE ARCHITECT OF ANY DISCREPANCIES. FAILURE TO DO SO INDICATES THAT THE CONTRACTOR ACCEPTS THE CONDITIONS AS THEY EXIST, AND SHALL PERFORM THE WORK
- 8. THE ELECTRICAL CONTRACTOR SHALL OBTAIN AND REVIEW THE AUDIO-VISUAL AND SPECIAL EQUIPMENT SUBMITTALS PRIOR TO SUBMITTING THE ELECTRICAL SUBMITTALS. ANY ELECTRICAL EQUIPMENT, CONDUIT, AND WIRE SIZE CHANGES RESULTING FROM THIS REVIEW SHALL ALSO BE SUBMITTED FOR APPROVAL.
- 9. FURNISH ALL EQUIPMENT AND LABOR, PERFORM ALL LABOR WITH SUPERVISION, BEAR ALL EXPENSES, AS NECESSARY FOR THE SATISFACTORY COMPLETION OF ALL WORK READY FOR OPERATION.
- 10. COMPLY WITH ALL LOCAL CODE, LAWS, AND ORDINANCES APPLICABLE TO ELECTRICAL WORK, THE STATE BUILDING CODE, 2017 NATIONAL ELECTRIC CODE AND 2020 FBC. OBTAIN ALL PERMITS REQUIRED BY LOCAL ORDINANCES.
- 11. OBTAIN ARCHITECT'S/ENGINEER'S APPROVAL OF ALL LIGHT FIXTURES, SWITCHES, RECEPTACLES, PANELBOARDS, ETC. PRIOR TO PURCHASING.
- 12. TERMINATIONS FOR ALL EQUIPMENT SHOWN TO HAVE TEMPERATURE RATING OF 75deg C PER NEC 2011 ART. 110.14 & TABLE 310.15(B)(16).
- 13. WHERE USED, PROVIDE MEANS TO SIMULTANEOUSLY DISCONNECT ALL UNGROUNDED CONDUCTORS AT THE CIRCUIT BREAKERS SERVING MULTI-WIRE BRANCH CIRCUITS IN ACCORDANCE WITH NEC 210.4(B).


DEMOLITION NOTES

- . ALL EXISTING SYSTEMS AND CONDITIONS SHOWN ON THE PLANS ARE APPROXIMATE. THE EXISTING ELECTRICAL CIRCUITS OF POWER, RECEPTACLES, LIGHTING, ETC. BEING REMOVED MAY NOT BE SHOWN ON THESE DOCUMENTS, BUT ARE TO BE REMOVED AS REQUIRED TO BUILD THIS PROJECT AND TO PERMIT NEW FINISHES, WALLS, ETC. THE CONTRACTOR SHALL FIELD VERIFY ALL CONDITIONS PRIOR TO BEGINNING ANY WORK AND SHALL NOTIFY THE ARCHITECT OF DISCREPANCIES. FAILURE TO DO SO INDICATES THAT THE CONTRACTOR ACCEPTS THE CONDITIONS AS THEY EXIST AND SHALL PERFORM ANY ADDITIONAL WORK NECESSARY TO PERFORM THE WORK AS SHOWN AND SPECIFIED.
- 2. IF A DEVICE IS BEING REMOVED AND THE CIRCUIT FEEDS OTHER LOADS FROM THE DEVICE, THEN THE WIRING SHALL BE MADE CONTINUOUS TO THE REMAINING LOADS. NO CIRCUIT CONTINUITY SHALL BE LOST.
- 3. IF A DEVICE IS BEING REMOVED AND NOT PART OF A DEMO WALL, THAT LOCATION SHALL BE RESTORED TO MATCH ADJACENT SURFACE.
- REMOVE ALL DISCONNECTS, WIRING, AND CONDUITS SERVING MECHANICAL EQUIPMENT BEING REMOVED OR RELOCATED.
- . CONTRACTOR TO REMOVE ALL CONDUITS, & ASSOCIATED WIRING FROM DEVICES BEING REMOVED BACK TO PANEL UNLESS NOTED OTHERWISE. WHEN ALL LOADS ON EXISTING BREAKERS ARE REMOVED, RELABEL BREAKER AS 'SPARE'.

30" MIN. OR EQUAL TO WIDTH OF PANEL

KEYNOTES:

- 1) EXISTING FEEDER TO REMAIN. RECONNECT TO NEW EQUIPMENT WHERE APPLICABLE.
- (2) EXISTING PANELBOARD SECTION 'ML-B' TO REMAIN AND BE RECONNECTED TO NEW SWITCHGEAR 'ML'. PANELBOARD IS SIEMENS TYPE 25, 208V/120V, 800A M.L.O.
- (3) EXISTING 300KVA, 480V-208Y/120 DRY-TYPE TRANSFORMER TO REMAIN. RECONNECT TO NEW SWITCHGEAR.
- (4) EC SHALL INSTALL EXISTING SURGE SUPPRESSOR IN NEW SWITCHGEAR 'ML'.
- (5) 45KVA DRY TYPE TRANSFORMER; 480Y/277V 208Y/120V.
- 6) REPLACE EXISTING 800A, 208Y/120V, 3ø, 4W SWITCHGEAR WITH NEW 800A, 208Y/120V, 3ø, 4W SWITCHGEAR. SECTION 'ML-1' IS 1600A M.B. AND SECTION 'ML-2' CONTAINS BRANCH CIRCUITS BREAKERS. NEW SWITCHGEAR 'ML-2' SHALL HAVE ADEQUATE SPACES TO RE-FEED ALL EXISTING EQUIPMENT. REFER TO SHEET 'E-101' FOR SWITCHGEAR 'ML2' SCHEDULE. NEW SWITCHGEAR GROUND IS TO BE BONDED TO EXISTING SERVICE ENTRANCE GROUND. EXISTING GEAR ITE UNI-POWER.
- (7) EXISTING HOUSEKEEPING PAD TO REMAIN AND MODIFIED (IF REQ'D) FOR NEW GEAR.
- (8) 4" HIGH HOUSEKEEPING PAD SHALL BE 4" LARGER THAN FOOTPRINT OF EQUIPMENT. COORDINATE FINAL
- MOUNTING LOCATION WITH OWNER. (9) EXISTING SF6 AIR SWITCH TO BE REPLACED WITH NEW SF6 AIR SWITCH. RECONNECT TO INCOMING UNDERGROUND
- PRIMARY AND TO EXISTING FEEDER GOING TO EXISTING 750 KVA TRANSFORMER.
- (10) EXISTING UNDERGROUND PRIMARY TO REMAIN. RECONNECT TO NEW SF6 AIR SWITCH.

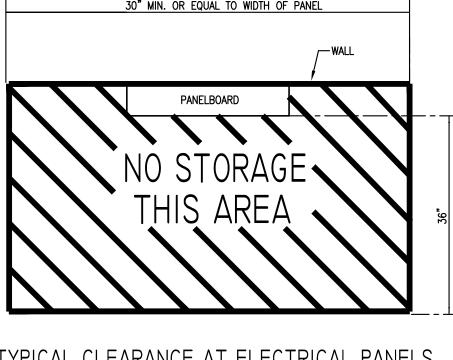

ELECTRICAL LEGEND

120/208 VOLT PANELBOARD

EXISTING 120/208 VOLT PANELBOARD

NON-FUSIBLE_DISCONNECT SWITCH; XX/YY/ZZ WHERE X INDICATES AMPERAGE,

300 (40)

200 (40)

200 (40)

104 (530)

Y INDICATES # OF POLES, AND Z INDICATES NEMA RATING

BRANCH CIRCUITING

RUN CONCEALED UNDER FLOOR OR IN GRADE

LIQUID—TIGHT FLEXIBLE CONDUIT CONNECTION

NEW Panel

208Y/120V

3ø, 4W

NUMERALS INDICATE PANEL AND CIRCUIT NUMBER.

PANEL

208Y/120V 3ø, 4W

PANEL

208Y/120V 3ø, 4W

3ø, 4W

FOURTH FLOOR

THIRD FLOOR

SECOND FLOOR

FIRST FLOOR

SURFACE MOUNTED CONDUIT; RUN PARALLEL OR PERPINDICULAR TO BUILDING LINES

RUN CONCEALED IN CEILING OR WALLS


PANELS AND POWER

MISCELLANEOUS

A.F.F. ABOVE FINISH FLOOR

B.F.C. BELOW FINISHED CEILING

TYPICAL CLEARANCE AT ELECTRICAL PANELS

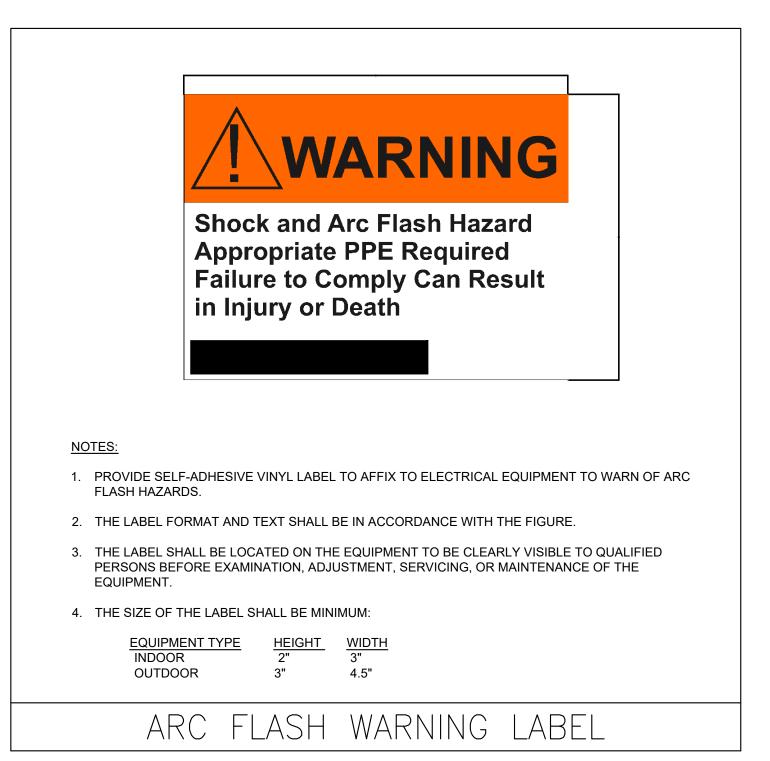



850.526.3447 www.watford-engineering.com Florida Certificate of Authorization: 27825

Anthony L Davis, PE Florida License 57419

FOR CONSTRUCTION

Anthony L Davis, State of Florida, Professional Engineer, License No. 57419 This item has been digitally signed and sealed by Anthony L Davis on the

Printed copies of this document are not considered signed and sealed and the signature must be verified on any electronic copies.

FOSTER-TANNE TALLAHASSEE, Description 2023-085 PROJECT NUMBER:


> DRAWN BY: ALD DESIGNED BY:


03-29-2024

DATE:

ELECTRICAL GENERAL NOTES, LEGEND AND SCHEDULES

E-001

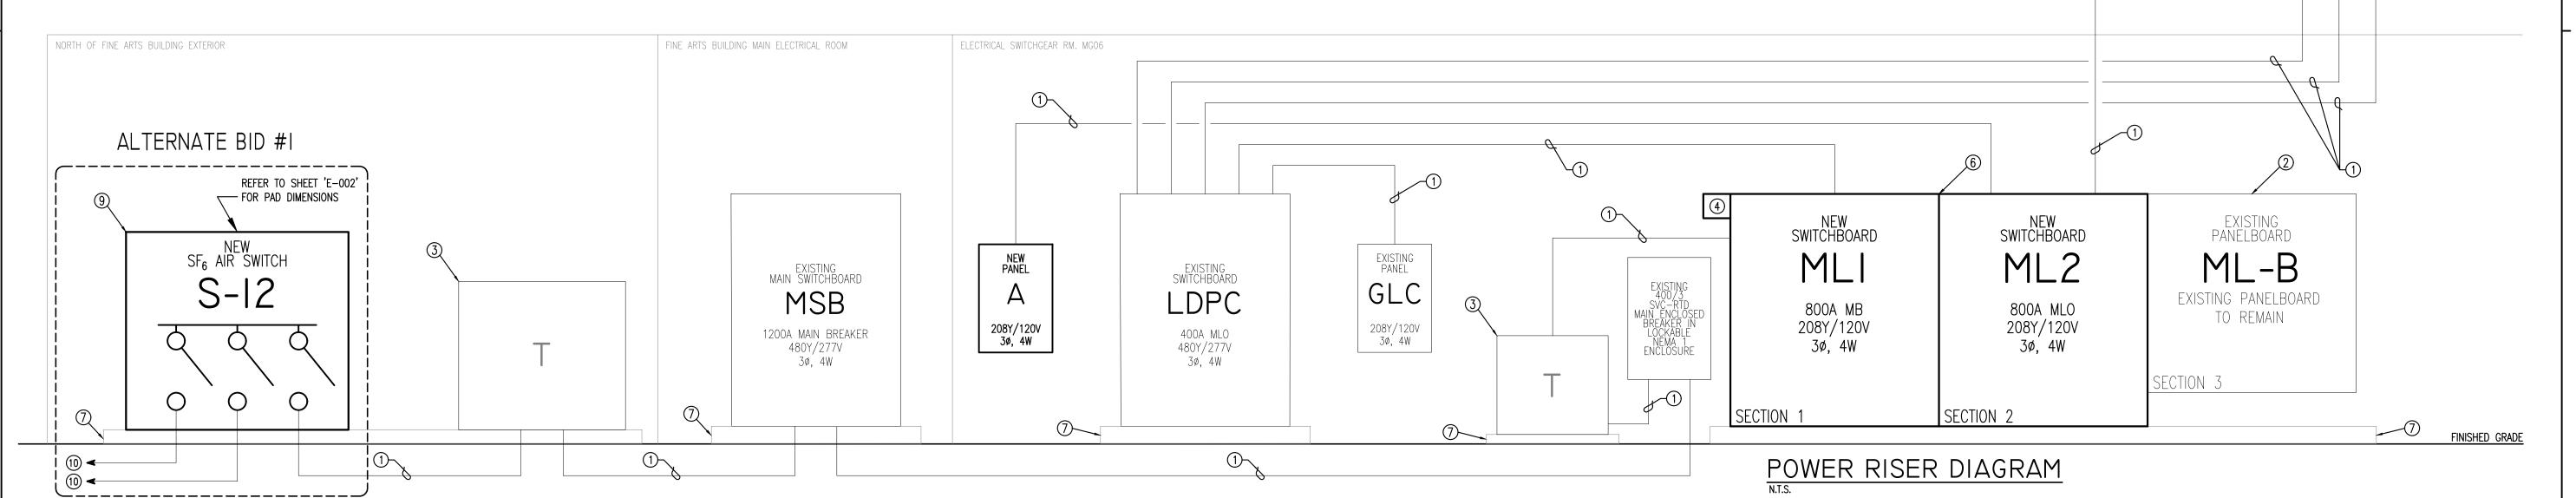

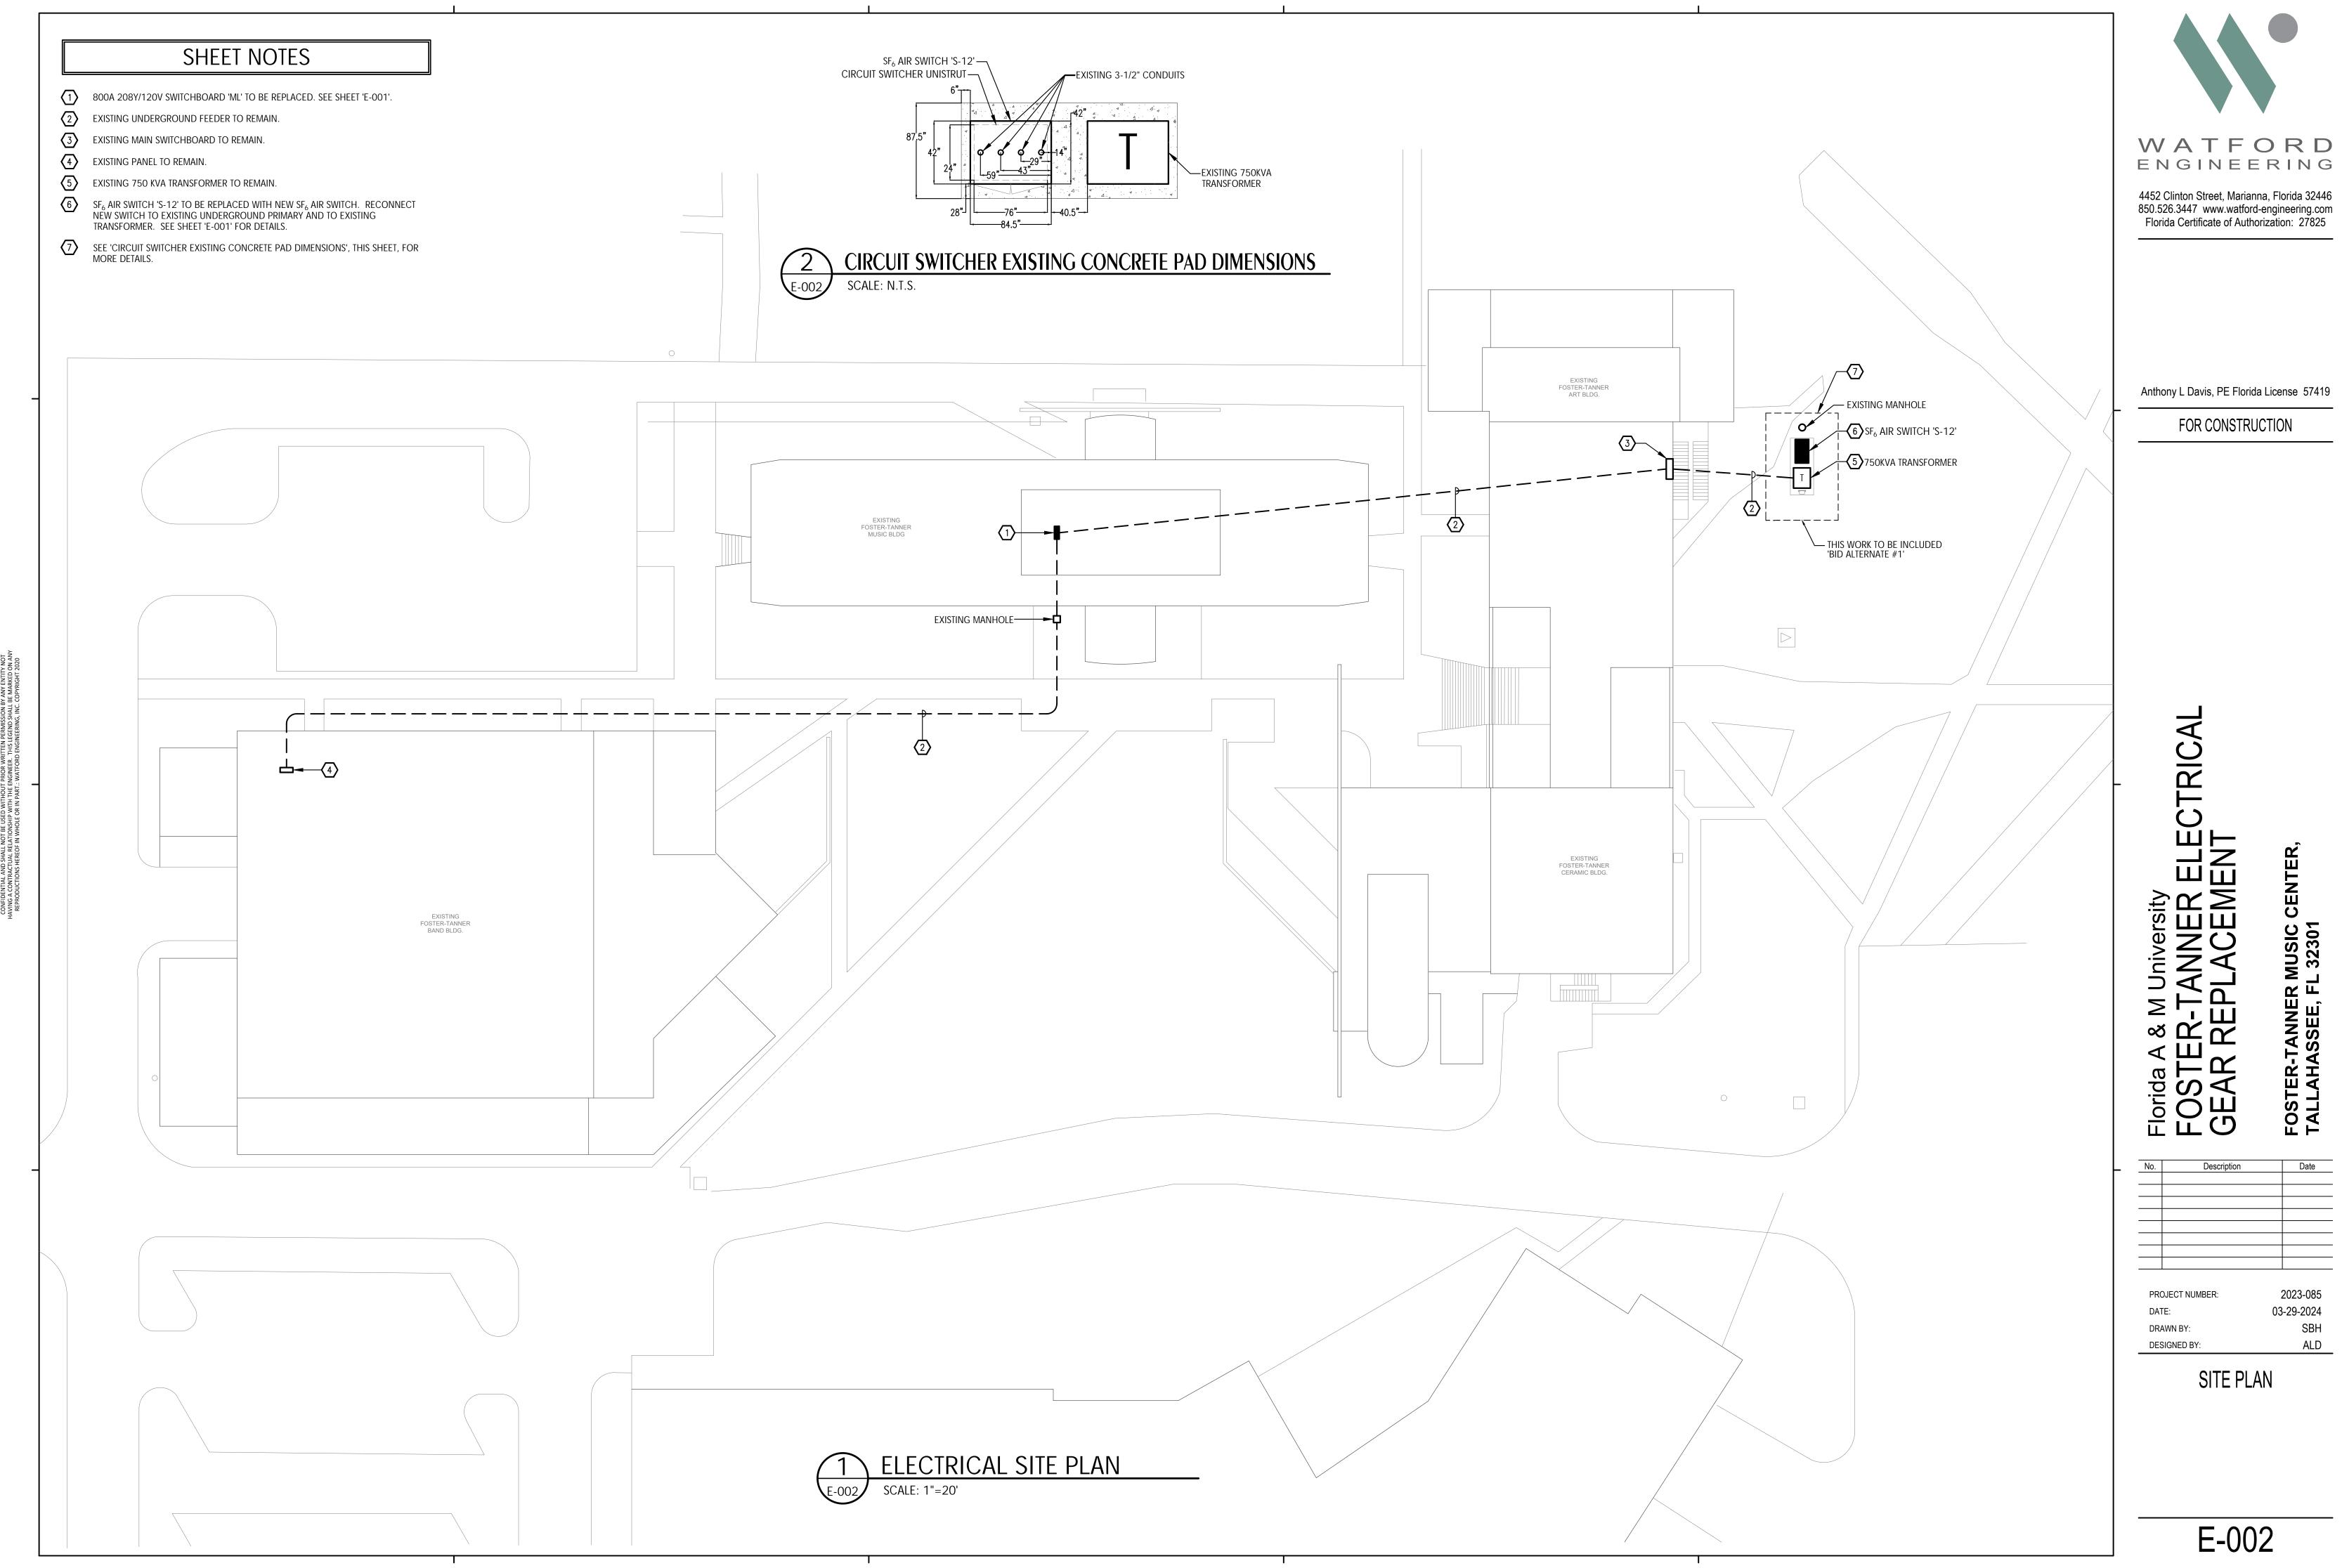

SHEET NOTES

- REPLACE EXISTING ITE, 800 AMP, 208Y/120V, 3Ø, 4W, 2-SECTION SWITCHBOARD WITH NEW 800 AMP, 208Y/120V, 3Ø, 4W, SWITCHBOARD. RECONNECT TO EXISTING FEEDER FROM EXISTING SIEMENS STEP-DOWN TRANSFORMER LOCATED IN 'ELECTRICAL SWITCHGEAR RM. MG06'. LABEL NEW SWITCHBOARD 'ML'. INSTALL NEW BREAKERS SIZED TO MATCH BREAKERS IN SWITCHBOARD BEING REPLACED. RECONNECT ALL EXISTING LOADS TO NEW SWITCHBOARD. REFER TO SWITCHBOARD SCHEDULE ON THIS SHEET AND RISER DIAGRAM ON SHEET 'E-001' FOR MORE INFORMATION.
- EXISTING SWITCHBOARD SECTION 'ML-B', IN 'ELECTRICAL SWITCHGEAR RM. MG06 ', WAS ADDED IN A PREVIOUS PROJECT. THE 800 AMP ITE SWITCHBOARD IN 'ELECTRICAL SWITCHGEAR RM. MG06', THAT IS BEING REPLACED WITH NEW SWITCHBOARD , 'ML', WAS CONNECTED TO SWITCHBOARD SECTION 'ML-B' SWITCHBOARD 'A'


 AND EXISTING FEEDER TO SWITCHBOARD 'B' ARE TO REMAIN AS IS. RECONNECT EXISTING FEEDER TO NEW SWITCHBOARD 'B'. NOTE: EC TO ENSURE THE GROUND OF NEW SWITCHBOARD 'B' IS BONDED TO THE GROUND OF EXISTING MAIN SWITCHBOARD
- PRIOR TO SUBMITTING BID, EC SHALL MAKE SITE VISIT AND ASCERTAIN ALL CONDITIONS NECESSARY FOR PROVIDING AN ACCURATE BID. IF THE EXISTING CONCRETE HOUSE-KEEPING PAD REQUIRES MODIFYING FOR NEW GEAR, EC SHALL INCLUDE IN BID.

54"	28	· · ·	4"	
13.5"		EXISTING SIEMENS 800A, 120/208V PANELBOARD TO REMAIN	38"	
 		EXISTING SIEMENS 800A, 120/208V PANELBÖARD TO REMAIN	38"	
 	2	0.5"	←	

SWITCHBOARD 'ML' EXISTING PAD DIMENSIONS
SCALE: N.T.S.

	20 VOLT, 30, 4W MP RATED SECTION (800 AMP SUPPLY) EQUIPMENT SERVED	BREAKER		LOAD KVA		BREAKER			CKI
		POLE	TRIP	LUAD	r v A	POLE	TRIP		
1	SPACE ONLY	3				20	3	PANEL 'A'	2
3	PANEL 'L1'	3	70			80	3	SPARE	4
5	PANEL 'L2'	3	100			100	3	PANEL 'L3'	6
7	PANEL 'L4'	3	100				3	SPACE ONLY	8
9	SPARE	3	30				3	SPACE ONLY	10
11	SPACE ONLY	3					3	SPACE ONLY	12
13	SPARE	3	200				3	SPACE ONLY	14
15	SPACE ONLY	3					3	SPACE ONLY	16

				PANEL '.	Δ'			
CKT	LOAD DESCRIPTION	BRE. POLE	AKER AMP	LOAD KV	\	AKER Pole	1 1 1 1 1 1 1 1 1 1 1 1 1 1 1 1 1 1 1	PTION CKT
1	EXISTING CIRCUIT	1	20		20	1	EXISTING CIRCUIT	2
3	EXISTING CIRCUIT	1	20		20	1	EXISTING CIRCUIT	4
5	EXISTING CIRCUIT	1	20		20	1	EXISTING CIRCUIT	6
7	EXISTING CIRCUIT	1	20		20	1	EXISTING CIRCUIT	8
9	EXISTING CIRCUIT	1	20			1 1	SPACE ONLY	10
11	SPACE ONLY							12
13								14
15								16
17								18
19								20
21								22
23	↓					<u> </u>	→	24

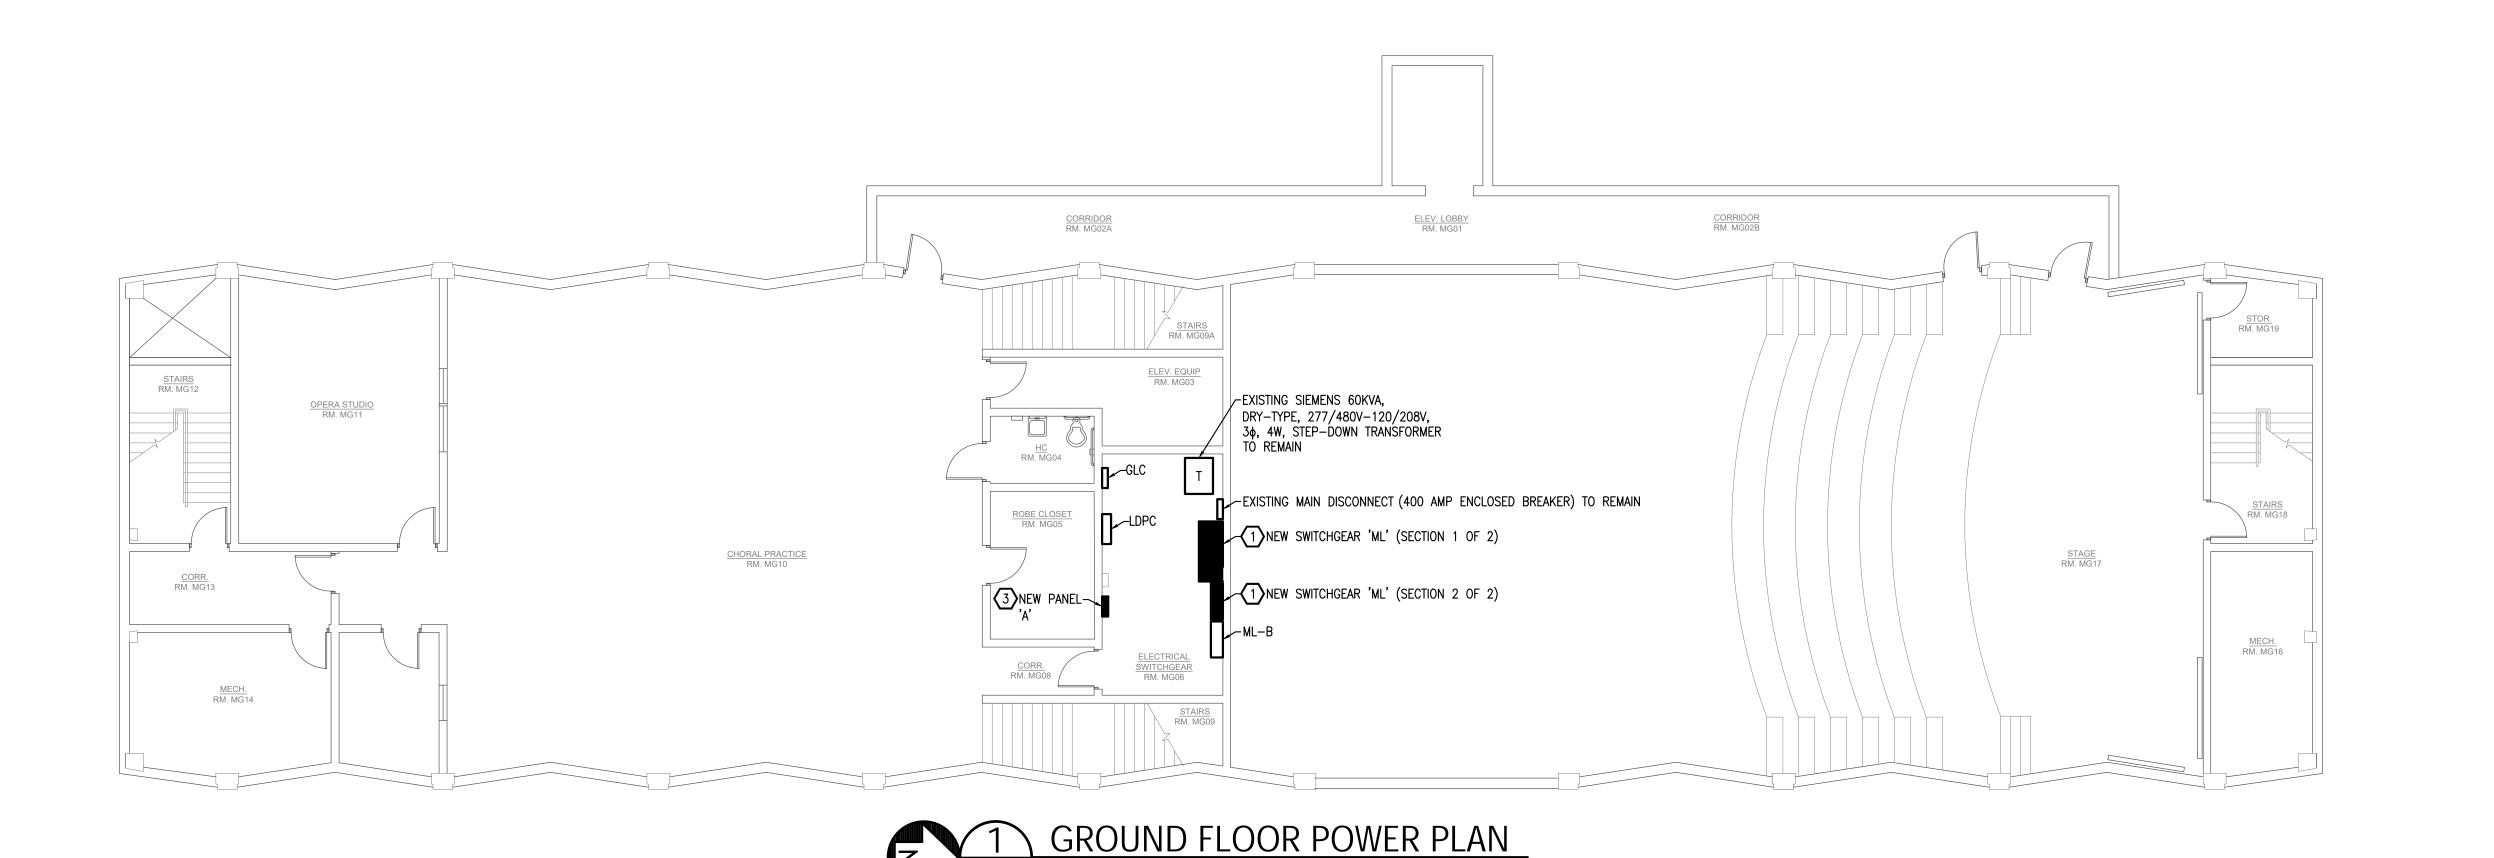



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FOR CONSTRUCTION

OSTER-TANNER ELECTRICATE REPLACEMENT

No. Description Date

PROJECT NUMBER: 2023-085

DATE: 03-29-2024

DRAWN BY: KEF

DESIGNED BY: ALD

ELECTRICAL GROUND FLOOR POWER PLAN

E-101